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STAPLE

# basic education

Department: **Basic Education REPUBLIC OF SOUTH AFRICA** 

NATIONAL SENIOR CERTIFICATE

**GRADE 12** 

**ENGINEERING GRAPHICS AND DESIGN P1 NOVEMBER 2021** 

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**MARKS: 100** 


TIME: 3 hours

This question paper consists of 6 pages.

Barcode label

### **INSTRUCTIONS AND INFORMATION**

- 1. This question paper consists of FOUR questions.
- 2. Answer ALL the questions.
- 3. ALL drawings are in first-angle orthographic projection, unless otherwise stated.
- 4. ALL drawings must be prepared using pencil and instruments, unless otherwise stated.
- 5. ALL answers must be drawn accurately and neatly.
- 6. ALL the questions must be answered on the QUESTION PAPER, as instructed.
- 7. ALL the pages, irrespective of whether the question was attempted or not, must be re-stapled in numerical sequence in the TOP LEFT-HAND CORNER ONLY.
- 8. Time management is essential in order to complete all the questions.
- 9. Print your examination number in the block provided on every page.
- 10. Any details or dimensions not given must be assumed in good proportion.

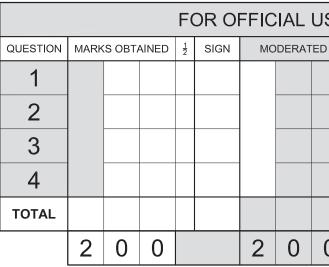


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#### Engineering Graphics and Design/P1

NSC SYMBOL LEGEND: NOTE: **QUESTION 1: ANALYTICAL (CIVIL)** LAND SURVEYOR'S CERTIFICATE OF THE CIAPLE Contractors must verify all dimensions and CORNER HEIGHTS AND BOUNDARY LENGTHS Pp 1. SHRUBBERY levels on site before commencing work. OF SUB-A AND SUB-B OF STAND 32. Given: Architects to be notified immediately of any Ŵ The site plan of newly subdivided STAND 32 with new boundary and building lines as well as a proposed new house CORNER HEIGHTS IN | BOUNDARY LENGTHS discrepancies. 2. PALM TREES METRES IN METRES and garage, a title panel and a table of questions. The drawing is not presented to the indicated scale. 3. DECIDUOUS TREES ARCHITECT'S SIGNATURE . 351.5 38.16 А AB Instructions: В 349,2 CLIENT'S SIGNATURE ВC 60 Complete the table below by neatly answering the questions, which refer to the accompanying drawing, title panel and С 351,5 CD 38,16 civil content. ANSWER 20 D 352,2 DA 60 In the space below, draw, in neat QUESTIONS Е 351.5 FD 33.8 freehand, the front view and top view F 351,7 33,8 of the SANS 10143 graphical symbol EG 1 What is the project number? 1,8 m CONCRETE WALL for a BIDET. G 350,4 FG 34,56 2 Who prepared the drawing? 3 What is the date of the first revision? STAND 18 Name the company that printed the drawing. 4 2000 BL RE 〔1〕 5 What size pipe is used for the new sewer line? RE 6 What does the abbreviation IC at 1 stand for? PROPOSED NEW NEW 7 What type of tree is indicated at 2? IF HOUSE GARAGE 8 Name the constructed feature at 3. What is indicated by the arrow at 4? 9 2000 BL NEW Ø100 IE SEWER LINE 10 Name the feature at 5. IE LAID AT 1:30 RE How many inspection eyes are there on the proposed new 11 SUB-B OF house? STAND 32 Ú DEMOLISH EXISTING UTBUILDING In what colour should drain and soil pipes be indicated on 12 drainage installation drawings? ADD NEW STORM WATER DRAIN AT 2021-02-14 With reference to the building regulations, why should the 2 2000 BI 13 LOWEST CORNER existing outbuilding be demolished now? **INCREASE WIDTH** SUB-B 2000 BL 2021-01-23 1 What is the fall of the existing sewer line? 14 OF DRIVEWAY What is the shortest distance from the existing house to NEW 3,6 m DRIVEWAY FOR 15 REVISION DATE DESCRIPTION Austen Street in metres? EXISTING With reference to the second revision, closest to which (5) HOUSE CLASSIC DESIGN 16 corner of SUB-B of STAND 32 should a new stormwater ARCHITECTS www.clasdes.co.za drain be placed? 459 CONCORD RD 2000 BL STAND 30 Ξ STAND 34 CAPE TOWN With reference to the north point, what is the direction of 2000 17 flow of the municipal sewer line? DATE OF PRINT: PRINTED BY: DUPLEX PRINTING 2021-02-21 In the space below (ANSWER 18), determine the perimeter of 18  $(\mathbf{2})$ ÉXISTING` new driveway, in metres. DRAWING TITLE: SUB-A OF DRIVEWAY SITE PLAN STAND 32 In the space below (ANSWER 19), determine the total area of 19 metres. PROJECT 5000 BL In the space in the title panel (ANSWER 20), draw, in neat free PROPOSED NEW HOUSE AND GARAGE  $(\mathbf{4})$ 20 3 ON SUBDIVISION B OF STAND 32 FOR the SANS 10143 graphical symbol for a BIDET. ROSS WATSON, 25 AUSTEN STREET, PIKETBERG, 1965 D F 3 m PAVEMENT PROJECT NUMBER: DRAWING NUMBER ANSWER 18. Show ALL calculations 15900 JBV-500W AAG-2121 EXISTING SEWER LINE AUSTEN STREET 6 m WIDE LAID AT 1:40 DATE DRAWN CHECKED SCALE. 2600 2021-01-10 JOHN WAYNE 1:350 12400 REFERENCE CODE: Q1R-2021 MН SITE PLAN SCALE 1:350 8000

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[30]

ANSWERS						
	1					
	1					
	1					
	1					
	1					
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	1					
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	2					
	1					
	2					
	1					
	2					
of SUB-B of STAND 32, including the	3					
of the proposed new house in square	3					
eehand, the front view and top view of	4					
TOTAL	30					
ANSWER 19. Show ALL of	alcul	ations	5.			
2000						
	2					
EXAMINATION NUMBER 2						

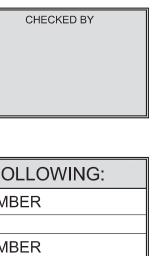STAPLE

## QUESTION 2: INTERPENETRATION AND DEVELOPMENT

#### Given:


- The top view and incomplete front view of a connecting piece for a ventilation system. The connecting piece consist of a right equilateral triangular tube and a right regular hexagonal tube. The axes of both tubes lie in a common vertical plane.
- An auxiliary view of the triangular tube.

#### Instructions:


Draw, to scale 1 : 1, the following views of the two tubes:

- 2.1 The given top view
- 2.2 The right view
- 2.3 The complete front view, clearly showing the curve of interpenetration
- 2.4 The development of the triangular tube. Make edge 'S-S' the seam.
- Planning is essential.
- Show ALL hidden detail and folding lines.
- Show ALL construction.

[38]

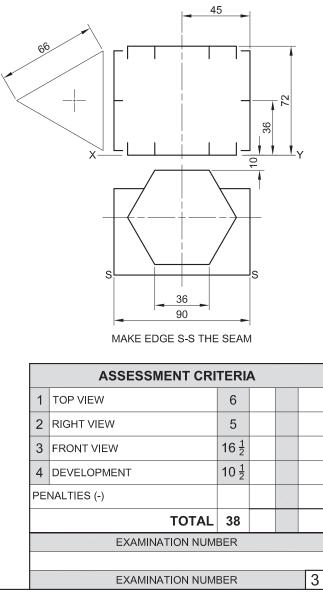


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	ASSESSMENT CRITERIA							
1	CONSTRUCTION	6						
2	WALLS + CUPBOARD + WINDOW	20						
3	TABLE + MIRROR	14						
PE	PENALTIES (-)							
	TOTAL 40							
	EXAMINATION NUMBER							
	EXAMINATION NUMBER							

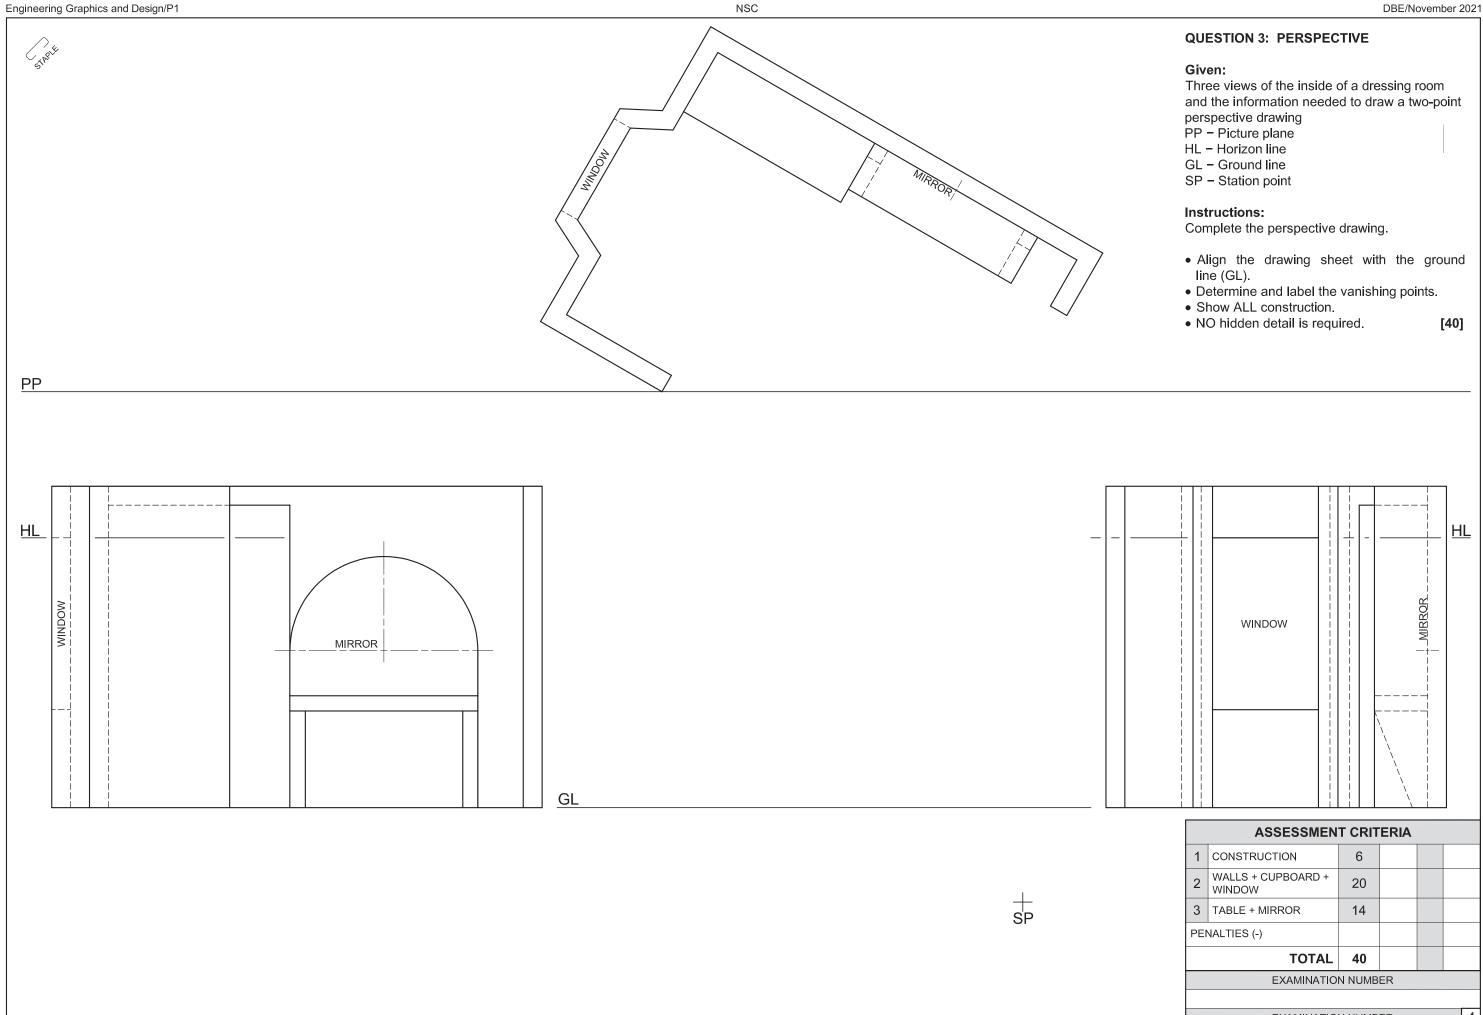

### **QUESTION 4: CIVIL DRAWING**

- The incomplete north elevation of a **new house**, showing the walls, the window and door openings, the veranda, the roof and labels
- The incomplete floor plan showing the walls, positions of the doors, windows, fixtures and electrical layout
- A schematic diagram of a roof truss at A-A and roof notes • The incomplete foundation, external wall and veranda detail Room and area designations as well as floor finishes
- A table of rainwater items
- A door and window schedule
- A table of electrical symbols
- A table of roof components
- A table of fixtures
- The incomplete floor plan and the ground line of the new house, drawn to scale 1 : 50, and the incomplete foundation and a break line for the detailed section, drawn to scale 1:20, on page 6.
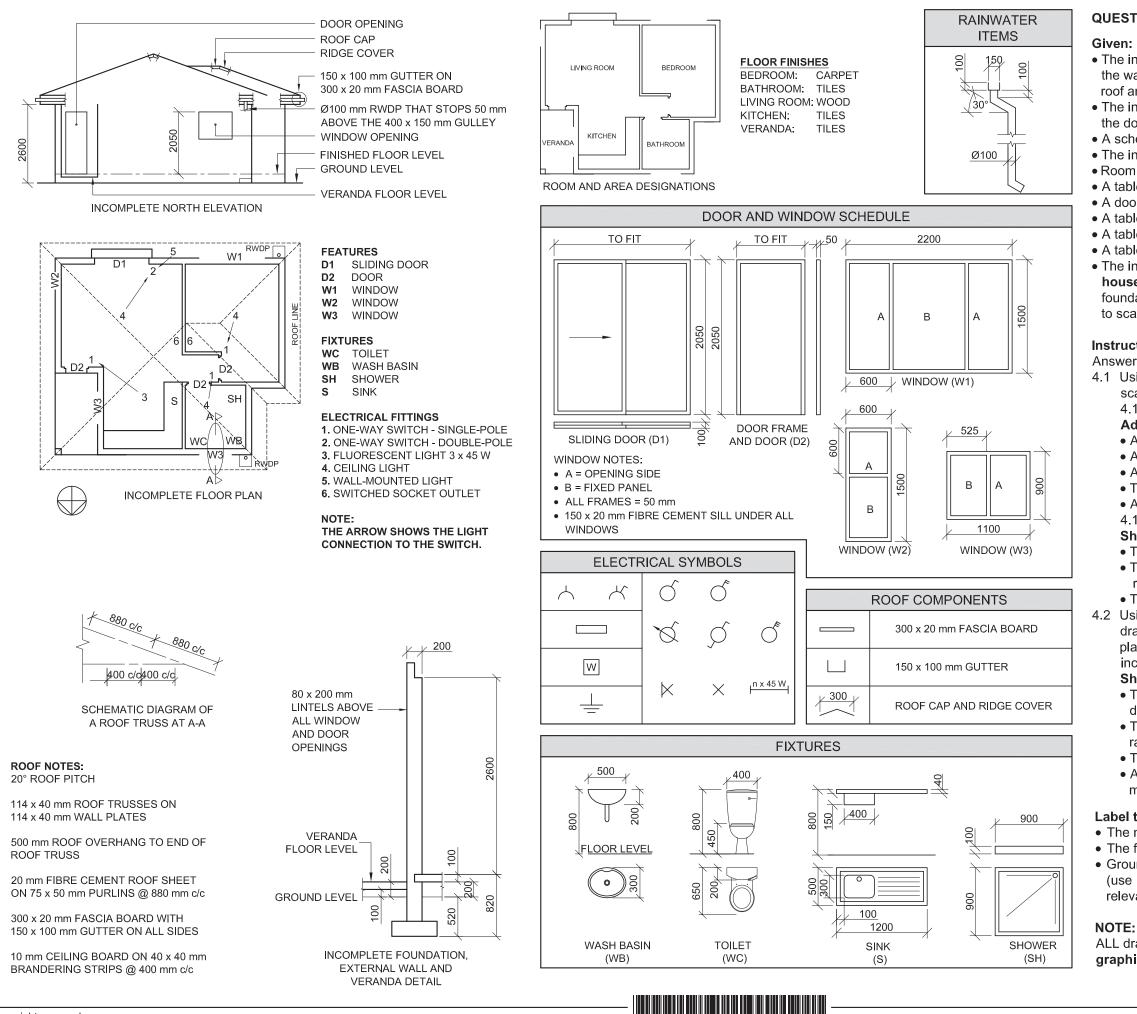
#### Instructions:

- Answer this question on page 6.
- 4.1 Using the given incomplete floor plan, draw, to scale 1 : 50, the following views of the **new house**:

#### 4.1.1 THE COMPLETE FLOOR PLAN

### Add the following features to the drawing:

- ALL doors and windows
- ALL fixtures as indicated by the abbreviations
- ALL electrical fittings as indicated by the numbers
- The complete roof lines
- ALL hatching detail

### 4.1.2 THE COMPLETE NORTH ELEVATION

- Show the following features on the drawing: The outside walls, veranda, window and door detail
- The roof detail, including the fascia boards, gutters, rainwater down-pipe and gulley
- The finished floor level
- 4.2 Using the given foundation and break line on page 6, draw, to scale 1 : 20, a **DETAILED SECTION** on cutting plane A-A of the area in the ellipse shown on the incomplete floor plan.

#### Show the following features on the drawing:

- The complete foundation, external wall and window detail
- The roof detail, including the fascia board, gutter, rainwater down-pipe and gulley
- The wash basin to the west of cutting plane A-A
- ALL hatching detail. ONLY the substructure hatching may be drawn in neat freehand.

#### Label the following:


- The north elevation
- The floor finishes
- Ground level, finished floor level and damp-proof course (use the correct abbreviations and show it on ALL the relevant views)

ALL drawings must comply with the guidelines and graphical symbols as contained in the SANS 10143. [92]

5

STREE

### GL

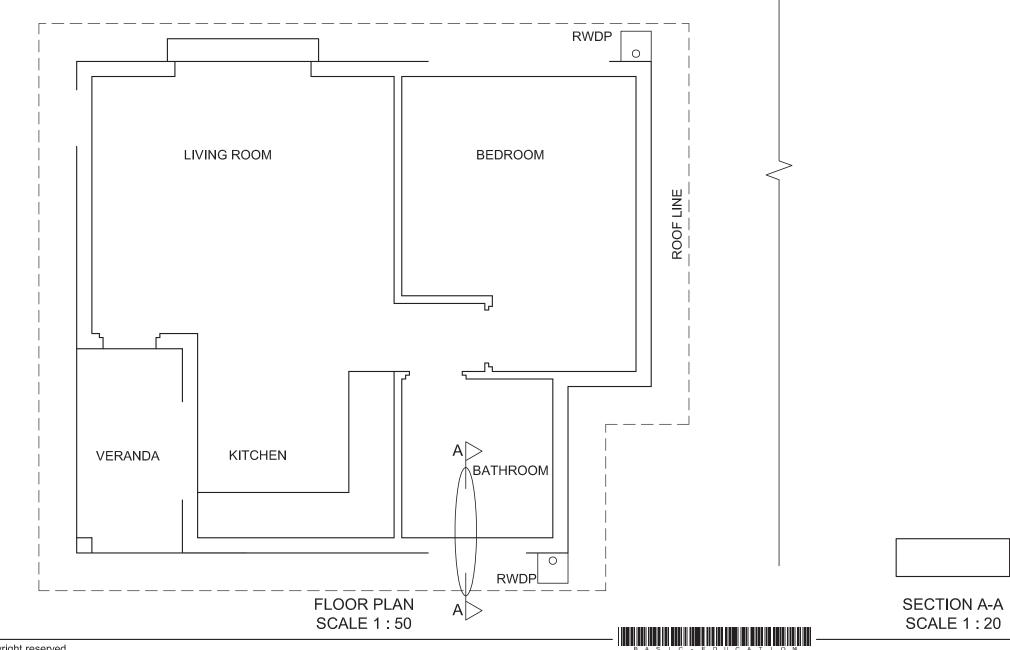

MARK ALLOCATION FOR SECTION OF ROOF		FOR OFFICIAL USE ONLY		
		INCORRECT SCALE(S)		
A		USED		
В		NON-ALIGNMENT OF VIEWS		
С				
D		VIEW(S) ROTATED		
E		SECTION VIEWED		
F				
G		INCORRECT LETTERING		
н				
TOTAL		TOTAL		

ASSESSMENT CRITERIA						
FLOOR PLAN						
		POSSIBLE	OBTAINED	SIGN	MODERATED	
1	DOORS + WINDOWS	13				
2	FIXTURES + ROOF LINES	11				
3	ELECTRICAL	8 <u>1</u>				
4	HATCHING	3				
5	LABELS	$2\frac{1}{2}$				
รเ	JBTOTAL	38				
	Ν	ORTH EI	EVATIO	N		
1	ROOF + RWDP + GULLEY	10 <sup>1</sup> / <sub>2</sub>				
2	WALLS + STEP + FFL	4				
3	DOOR + WINDOW	6				
4	LABELS	1				
รเ	JBTOTAL	21 ½				
	D	ETAILED	SECTIC	N		
1	ROOF DETAIL	13 <del>1</del> /2				
2	SLAB, WALL, WINDOW + BASIN	12				
3	HATCHING	5 <u>1</u>				
4	LABELS	1 <u>1</u>				
SUBTOTAL 32 <sup>1</sup> / <sub>2</sub>						
TOTAL 92						
PENALTIES (-)						
	GRAND	TOTAL				
EXAMINATION NUMBER						
EXAMINATION NUMBER 6						