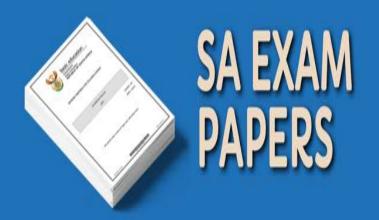


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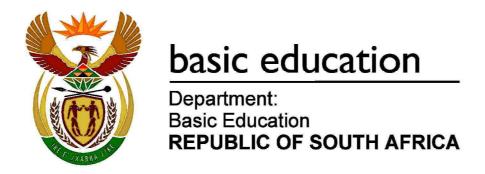
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NATIONAL SENIOR CERTIFICATE

GRADE 12

ENGINEERING GRAPHICS AND DESIGN P1 NOVEMBER 2022

MARKS: 100

TIME: 3 hours

This question paper consists of 6 pages.

	Barcode label	
1		

INSTRUCTIONS AND INFORMATION

- 1. This question paper consists of FOUR questions.
- 2. Answer ALL the questions.
- 3. ALL drawings are in first-angle orthographic projection, unless otherwise stated.
- 4. ALL drawings must be prepared using pencil and instruments, unless otherwise stated.
- 5. ALL answers must be drawn accurately and neatly.
- 6. ALL the questions must be answered on the QUESTION PAPER, as instructed.
- 7. ALL the pages, irrespective of whether the question was attempted or not, must be re-stapled in numerical sequence in the TOP LEFT-HAND CORNER ONLY.
- 8. Time management is essential in order to complete all the questions.
- 9. Print your examination number in the block provided on every page.
- 10. Any details or dimensions not given must be assumed in good proportion.

FOR OFFICIAL USE ONLY															
QUESTION	ON MARKS OBTAINED		AINED	<u>1</u>	SIGN	МО	DERAT	ED	1/2	SIGN	RE-	-MARKI	NG	<u>1</u>	SIGN
1															
2															
3															
4															
TOTAL															
	2	0	0			2	0	0			2	0	0		

•	
FINAL CONVERTED MARK	CHECKED BY
400	

COMPLETE THE FOLLOWING:
COMPLETE THE FOLLOWING.
CENTRE NUMBER
CENTRE NUMBER
EXAMINATION NUMBER
EXAMINATION NUMBER

Engineering Graphics and Design/P1 NSC DBE/November 2022

LAND SURVEYOR'S CERTIFICATE OF THE CORNER HEIGHTS AND BOUNDARY LENGTHS OF STAND 3414									
	ER HEIGHTS METRES	BOUNDARY LENGTHS IN MILLIMETRES							
Α	1600	AB	24230						
В	1600	вс	8370						
С	1599	CD	18380						
D	1599	DE	31200						
Е	1601	EA	32400						

SYMBOL LEGEND						
	EVERGREEN TREES					
0	BUSHES					
-x -x	2000 HIGH SECURITY FENCE					
~~~	1800 HIGH PALLISADE FENCE					

NI3 NIATIONAL ROAD 15 m ROAD RESERVE MH 1600 3600 BL EXISTING SEWERAGE LINE 1601 STINKWOOD LANE PROPOSED NEW STAND 3414 EXTENSION (2) (3) 2500 BL STAND 3413 DATE: 3,6 m WIDE 05/01/2022 CASPER VEHICLE ENTRY DOMBEYA STREET REFERENCE CODE: SITE PLAN SCALE 1:350


NOTE:

Contractors must verify all dimensions and levels on site before commencing work. Architects to be notified immediately of any discrepancies.

ARCHITECT'S SIGNATURE CLIENT'S SIGNATURE

ANSWER 18

In the space below, draw, in neat freehand, the SANS 10143 hatching (symbol) for a (18.1) FACE BRICK WALL, and graphical symbol for a (18-2) STAIRCASE

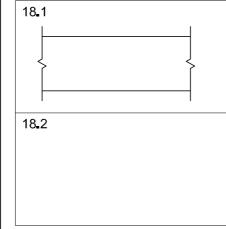

2	07/01/22	A	DD WATER METER	L I SA B				
1	06/01/22		DLOUR NEW	L ∥ SA B				
REVISION	DATE		DESCRIPTION	DRAWN				
KOMBELLA, JOUBERT & MINNAAR ARCHITECTURAL DESIGN 365 BORCHARDS AVENUE ERASMIA 0183 012 685 1857 www.kjmdesign.co.za								
PRINTED BY	:		DATE OF PRINT:					
STEVENS PRINTERS 08/01/2022								
DRAWING TITLE:								
SITE PLAN								

PROPOSED NEW ADDITION FOR MR N KEENAN

ON STAND 3414,

21 DOMBEYA STREET, HARRISMITH

DRAWING NUMBER:

CHECKED:

ANNIE Q

1 OF 5

SCALE:

1:350

PROJECT:

PROJECT NUMBER:

FTW2022-59

K1N-2022

DRAWN:

QUESTION 1: ANALYTICAL (CIVIL)

The site plan of an existing house with a proposed new extension, a title panel and a table of questions. The drawing has not been presented to the indicated scale.

Instructions:

Complete the table below by neatly answering the questions, which refer to the accompanying drawing, title panel and civil content_

		QUESTIONS ANSWERS	S	
	1	What does the number FTW2022-59 refer to?	1	
	2	Who is the client?	1	
	3	What is the title of the drawing?	1	
	4	What action was taken on 08/01/2022?	1	
	5	Who was responsible for preparing the revisions to the drawing?	1	
	6	How wide is the road reserve in millimetres?	1	
	7	Whose signatures are required on the site plan?	2	
	8	How many new inspection eyes are shown on the site plan?	1	
	9	What does the abbreviation RWDP stand for?	1	
	10	Which corner of STAND 3414 is the highest?	1	
	11	Determine the shortest distance from the proposed new extension to boundary line AB in metres.	1	
	12	What is indicated in BLUE on floor plans and/or sections?	2	
В	13	Name the feature at 1.	1	
В	14	What is indicated by the arcs at 2?	1	
\exists	15	Name the feature at 3₄	1	
/NI	16	What does the ratio 1:40 on the new sewerage line indicate?	1	
	17	Which elevation of the existing house faces the N3 national road?	2	
	18	In the space in the title panel (ANSWER 18), draw, in neat freehand, the SANS 10143 hatching (symbol) for a (18.1) FACE BRICK WALL, and graphical symbol for a (18.2) STAIRCASE.	4	
\dashv	19	In the space below (ANSWER 19), determine the total length of the 1800 high pallisade fence required for STAND 3414, in metres.	3	
-	20	In the space below (ANSWER 20), determine the total area of the house, including the new extension, in square metres. Show the answer to TWO decimal places.	3	
		TOTAL	30	



ANSWER 20 Show ALL calculations. 10800 EXAMINATION NUMBER 6000 6700 EXAMINATION NUMBER



QUESTION 2: SOLID GEOMETRY

Given:


- The front view and top view of a right square pyramid that rests against a right regular pentagonal prism
- An auxiliary view of the right square pyramid
- Cutting plane R-R

Instructions:

Draw, to scale 1:1, the following views of both solids:

- 2.1 The given front view
- 2.2 A sectional top view with the parts above cutting plane R-R removed
- 2.3 A sectional right view with the parts below cutting plane R-R removed
- 2.4 The true shape of the cut surfaces of BOTH solids
- Planning is essential.
- Show ALL hidden detail.
- Show ALL construction.

[37]

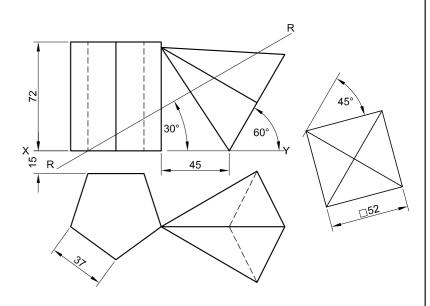

ASSESSMENT CRITERIA							
1	FRONT VIEW	7					
2	SECTIONAL TOP VIEW	12 ½					
3	SECTIONAL RIGHT VIEW	10					
4	TRUE SHAPE	6 ½					
5	5 CORRECT HATCHING						
PEN	ALTIES (=)						
	TOTAL	37					
EXAMINATION NUMBER							
	EXAMINATION NUMBER 3						

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Please turn over

QUESTION 3: PERSPECTIVE

Given:

Three views of a dub house and the information needed to draw a two-point perspective drawing PP - Picture plane

HL - Horizon line

GL - Ground line

SP - Station point


Instructions:


Complete the perspective drawing.


- Align the drawing sheet with the ground line (GL)
- Determine and label the vanishing points.
- Show ALL construction.
- Show depth at the windows_
- NO hidden detail is required.

[41]

ASSESSMENT CRITERIA								
1	CONSTRUCTION	6						
2	WALL + BASE	10 ½						
3	WINDOWS + OPENING	10						
4	ROOF	7 ½						
5	ARC	7						
PEN	ALTIES (=)							
	TOTAL	41						

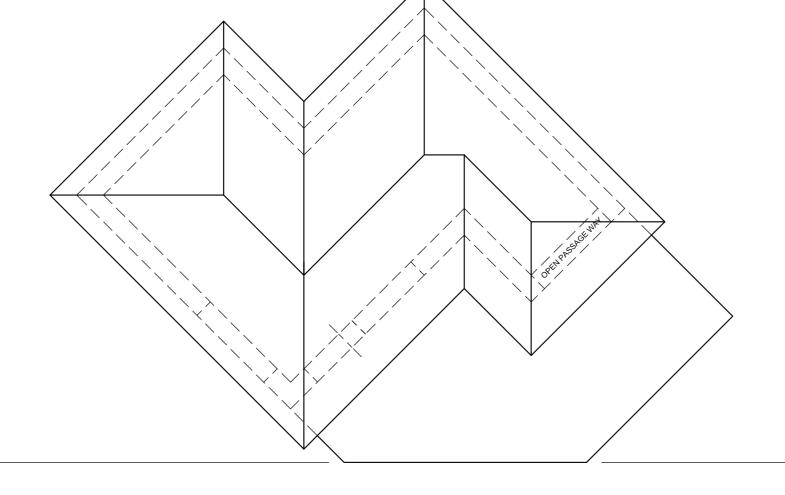

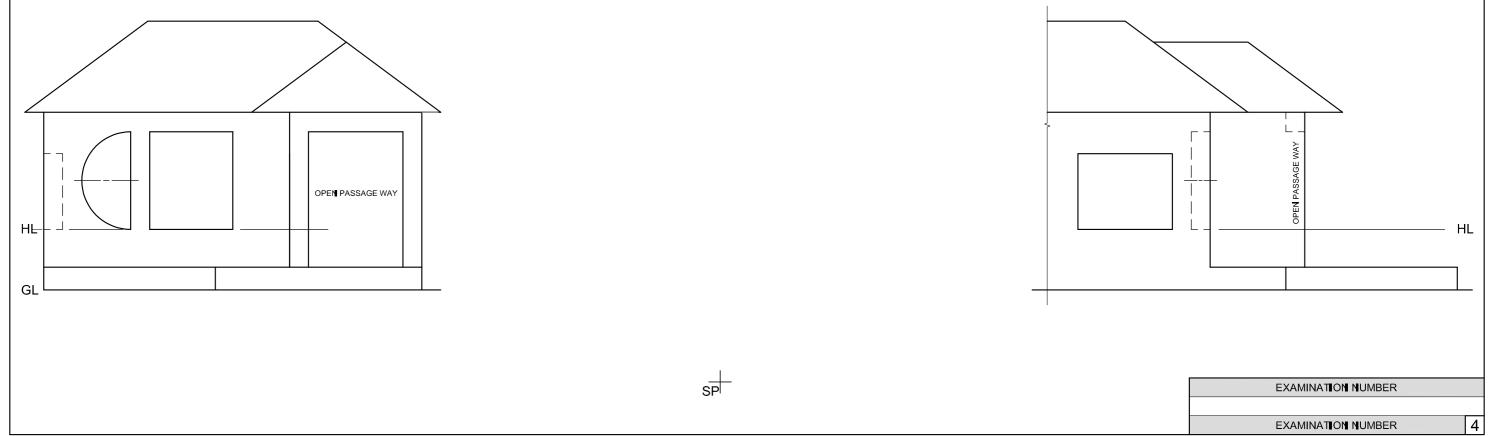


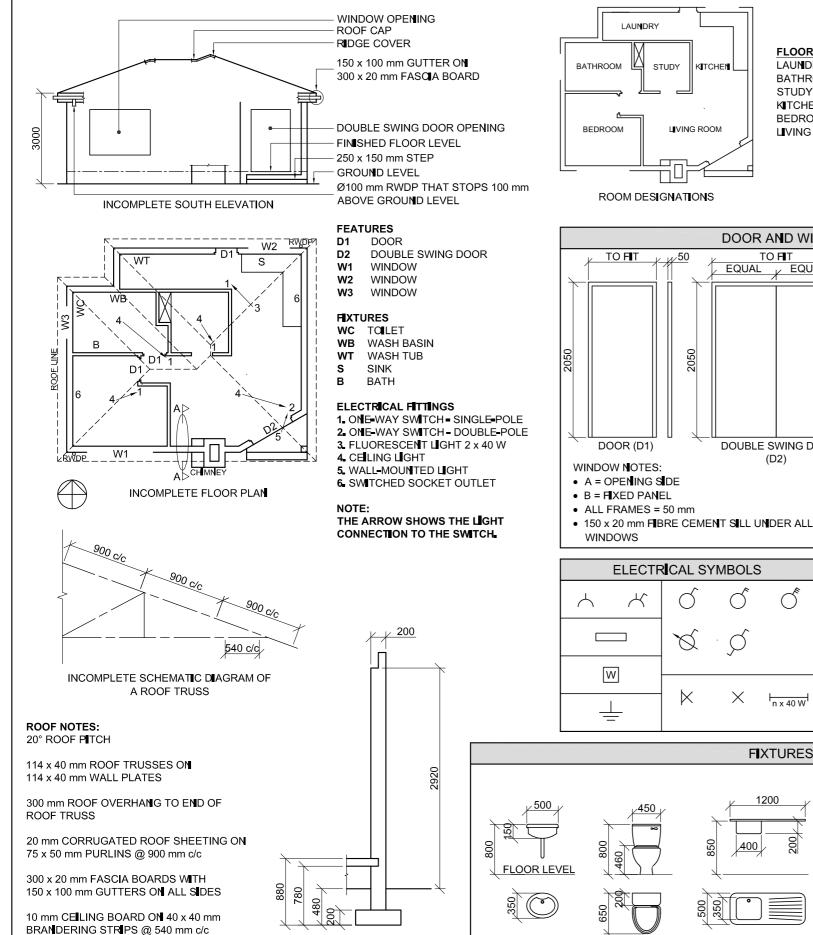



INCOMPLETE FOUNDATION


AND EXTERNAL WALL DETAIL


CHIMNEY DETAIL FLOOR FINISHES LAUNDRY: TILES KITCHEN BATHROOM: TILES CARPET STUDY: 45° KITCHEN: TILES BEDROOM: CARPET LIVING ROOM: WOOD 1100

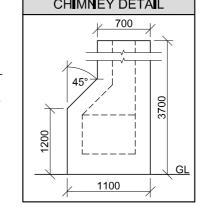


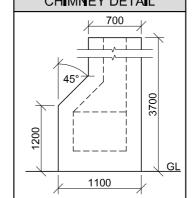


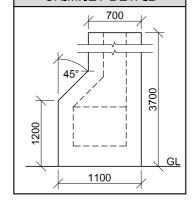

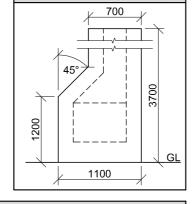

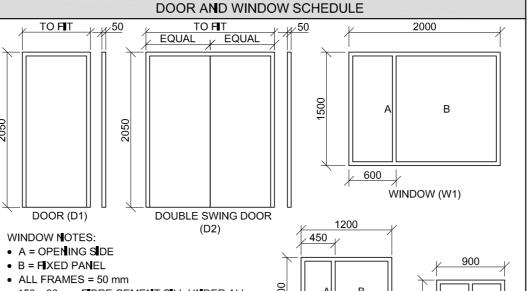

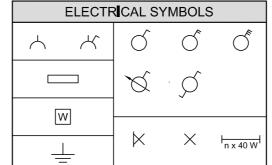

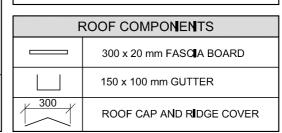

WINDOW (W2)

FIXTURES WASH BASIN TOILET SINK BATH WASH TUB (WC) (S) (WT) (WB) (B)

QUESTION 4: CIVIL DRAWING

Given:

- The incomplete south elevation of a **new house**, showing the walls, window and double swing door openings, step, position of the chimney, roof and labels
- The incomplete floor plan showing the walls, step, positions of the doors, windows, chimney and fixtures, as well as electrical
- An incomplete schematic diagram of a roof truss and roof
- The incomplete foundation and external wall detail
- Room designations and floor finishes
- A table with chimney detail
- A door and window schedule
- A table of electrical symbols
- A table of roof components
- A table of fixtures
- The incomplete floor plan and position of the ground level of the **new house**, drawn to scale 1:50, and the incomplete foundation and a break line for the detailed section, drawn to scale 1: 20, on page 6.

Instructions: Answer this question on page 6.

4.1 Using the given incomplete floor plan and ground level, draw, to scale 1:50, the following views of the new house:

4.1.1 THE COMPLETE FLOOR PLAN

Add the following features to the drawing:

- ALL doors and windows
- ALL fixtures as indicated by the abbreviations
- ALL electrical fittings as indicated by the numbers
- ALL the roof lines
- ALL hatching detail

4.1.2 THE COMPLETE SOUTH ELEVATION

Show the following features on the drawing:

- The outside walls, step, chimney, window and double swing door detail
- The roof detail, including the fascia boards, gutters and rainwater down-pipe
- The finished floor level
- 4.2 Using the given incomplete foundation and break line on page 6, draw, to scale 1: 20, a **DETAILED SECTION** on cutting plane A-A of the area in the ellipse shown on the incomplete floor plan

Show the following features on the drawing:


- The complete foundation and external wall detail
- The roof detail, including the fascia board and gutter
- The chimney and the double swing door and frame to the right (east) of cutting plane A-A
- ALL hatching detail. ONLY the substructure hatching may be drawn in neat freehand.

Label the following:

- The south elevation
- The floor finishes
- Ground level, finished floor level and damp-proof course (use the correct abbreviation and show it on ALL relevant views).

All drawings must comply with the guidelines and graphical symbols as contained in the SANS 10143. [92]

5

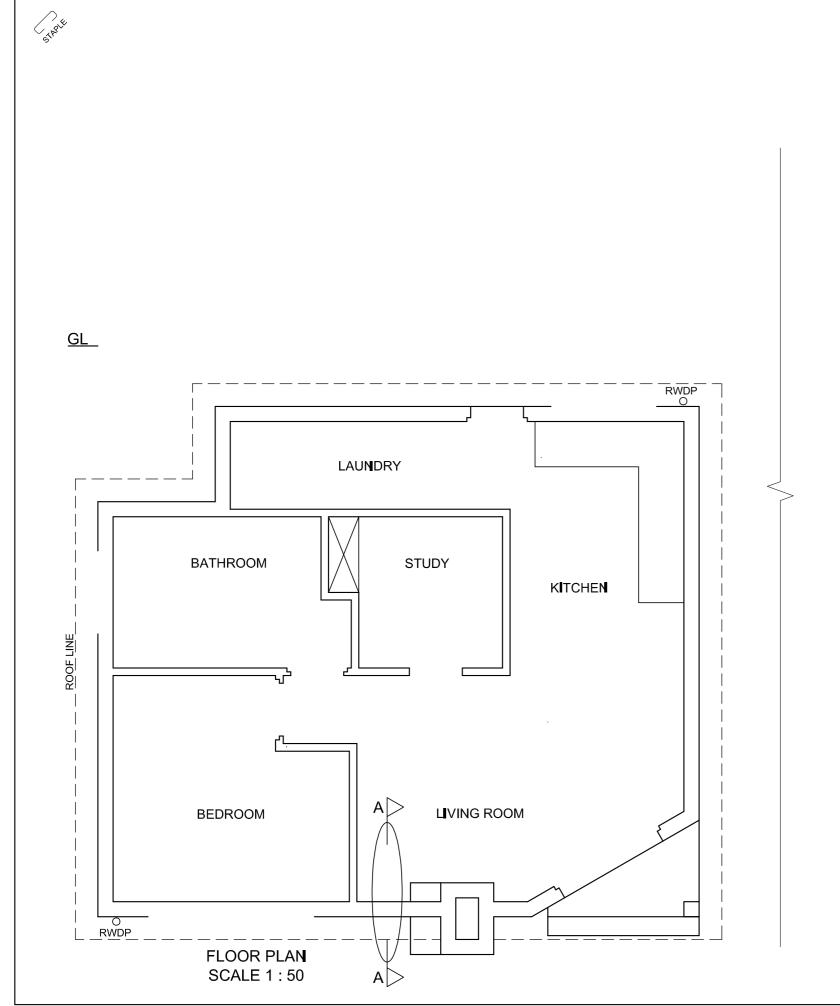

MARK ALLOCATION FOR		FOR OFFICIAL USE ONLY				
SECTION	OF ROOF	INCORRECT SCALE(S) USED				
В		NON-ALIGNMENT OF VIEWS				
С		VILVVO				
D		VIEW(S) ROTATED				
E		SECTION VIEWED				
F		INCORRECTET				
G		INCORRECT LETTERING				
н						
TOTAL		TOTAL	·			

ASSESSMENT CRITERIA									
FLOOR PLAN									
		POSSIBLE	OBTAINED	SIGN	MODERATED				
1	DOORS + WINDOWS	11							
2	FIXTURES + ROOF LINES	15							
3	ELECTR I CAL	10							
4	HATCHING	3							
5	LABELS	3							
SI	UBTOTAL	42							
	S	OUTH EL	EVATIO	N					
1	ROOF + RWDP	8 1 2							
2	WALLS + STEP + CHIMNEY + FFL	7							
3	DOOR + WINDOW	7							
4	LABELS	1							
SI	UBTOTAL	$23\frac{1}{2}$							
	DE	TA I LED	SECTIO	N					
1	ROOF DETAIL	11 ½							
2	SLAB + WALL + CHIMMEY	8							
3	HATCHING	3 1 2							
4	DOOR	$2\frac{1}{2}$							
5	LABELS	1							
SI	UBTOTAL	$26\frac{1}{2}$							
	TOTAL	92							
PEN	PENALTIES (-)								
GRAND TOTAL									
	EX	10 I TANIMA	NUMBER						
	EV	ΔΜΙΝΑΤΙΟ	J NI IMRED		6				
EXAMINATION NUMBER 6									

SECTION A-A

SCALE 1:20